

Facilities & Property Management 401 N. Dixon Street Portland, OR 97227-1865



2525 E Burnside St. Portland, OR 97214



02/26/25 G101

SITE PLAN

CONDUIT (CABLE TV) COMMUNITY ACCESS TELEVISION CIRCUIT BREAKER CCTV CLOSED CIRCUIT TELEVISION OFE CELLULAR FLOOR OFOI CKT CIRCUIT CLG CEILING CO CENTRAL OFFICE CPE CUSTOMER UNIVERSAL ENCLOSURE CT CURRENT TRANSFORMER CU COPPER CONCRETE UNIVERSAL ENCLOSURE DAS DISTRIBUTED ANTENNA SYSTEM dB DECIBEL DB DUCT BANK DOUBLE MAIN LUGS DML DN DOWN EQ **EQUAL DISTANT** ELECTRICAL CONTRACTOR ENTRANCE FACILITY SACP EM **EMERGENCY** SDP ELECTROMAGNETIC COMPATIBILITY SPD EMI ELECTROMAGNETIC INTERFERER EMT ELECTRIC METALLIC TUBING STS EMERGENCY POWER OFF ENTRANCE POINT EP EXPLOSION PROOF EMERGENCY RELEASE ERRCS EMERGENCY RESPONDER RADIO COMMUNICATION SYSTEM FIRE ALARM FIRE ALARM ANNUNCIATOR FIRE ALARM CONTROL PANEL FLA FULL LOAD AMPS FIBER OPTIC FSD FIRE SMOKE DAMPER GENERAL CONTRACTOR GROUND FAULT INTERRUPTER GFCI GROUND FAULT CIRCUIT INTERRUPTER TVSS GHz GIGAHERTZ GND GROUND GRC GALVANIZED RIGID CONDUIT GROUND GALVANIZED RIGID STEEL CONDUIT HANDHOLE HORSEPOWER HIGH PRESSURE SODIUM HIGH VOLTAGE ΗZ HERTZ INTERNATIONAL BUILDING CODE INTERMEDIATE DISTRIBUTION FRAME ISOLATE GROUND XFMR TRANSFORMER INTERRUPTING RATING XFSW TRANSFORMER SWITCH

KVA

KVAR

KW

MCB

MCC

MDF

MDP

MECH

AMPERE (AMP)

AIRBLOWN FIBER

ABOVE COUNTER

ALTERNATE

ANALOG

ARMORED

AUDIO VISUAL

ABF

ALT

ΑV

BDF

BOCT

ARCH

ABOVE ACCESS FLOOR

ABOVE FINISHED FLOOR

AUTHORITY HAVING JURISDICTION

AMPS INTERRUPTING CURRENT

ARCHITECT / ARCHITECTURAL

AUTOMATIC TRANSFER SWITCH

BUILDING DISTRIBUTION FRAME

BUILDING MANAGEMENT SYSTEM

AUDIO VISUAL CONTRACTOR

BONDING CONDUCTOR

BOTTOM OF CONDUIT

BOTTOM OF CABLE TRAY

NOTE

THIS IS A STANDARD LEGEND SHEET, THEREFORE, SOME SYMBOLS MAY APPEAR ON THIS SHEET THAT DO NOT APPEAR ON THE DRAWINGS.

WORK RESPONSIBILITY

ALL WORK SHALL BE COORDINATED WITH ALL TRADES INVOLVED. OFFSETS IN CONDUIT, DEVICES, BOXES, CONDUCTORS, AND TRANSITIONS AROUND OBSTRUCTIONS WHETHER SHOWN ON DRAWINGS OR NOT SHALL BE PROVIDED AT NO ADDITIONAL COST TO THE OWNER.

	GENERAL SYMBOLS
XXXX 123	EQUIPMENT DESIGNATOR SEE SCHEDULE.
E	EXISTING TO REMAIN
$\langle \mathbf{x} \rangle$	EXISTING TO BE REMOVED
$\langle R \rangle$	EXISTING TO BE RELOCATED
$\langle N \rangle$	NEW
(#)	KEYNOTE

CARD KEY READER STATION (4" SQ. BOX W/SINGLE-GANG RING MOUNT TOP OF READER AT 48" AFF/AFG (BY SECURITY \bigcirc VIDEO INTERCOM (AIPHONE): STATION, MASTER 0 0 DOOR CONTACT (POSITION) SWITCH (BY SECURITY CONTRACTOR) REQUEST TO EXIT SENSOR (BY SECURITY CONTRACTOR) LATCH RETRACTION EXIT DEVICE (BY DOOR HARDWARE) REQUEST TO EXIT SWITCH IN EXIT DEVICE (BY DOOR HARDWARE)

 $\times \times \times \times$

LIGHT SWITCH: OS = OCCUPANCY SENSOR, K = KEYED, 3 = 3-

LOW VOLTAGE DIMMER / PRESET CONTROL: D

SECURITY

MOTION DETECTOR: WALL, CEILING

PUSH BUTTON: P= PANIC

ELECTRIC LOCK CONNECTION

ELECTRIC DOOR CONTACT

DOOR RELEASE PANEL

DOOR OPERATOR/ADA RELEASE BUTTON

CAMERA: CCTV FIXED, PAN-TILT-ZOOM, 360°

ELECTRIC STRIKE (BY DOOR HARDWARE)

ELECTRONIC POWER TRANSFER (EPT) (BY DOOR HARDWARE)

TIMER SWITCH: T

CONTRACTOR) EMERGENCY RELEASE

STATION

REX

(40) (40) 40

ES

RX

EP

GENERAL NOTES (APPLIES TO ALL DRAWINGS)

- A. WHERE EXACT DIMENSIONS ARE NOT CALLED FOR, DO NOT SCALE DRAWINGS TO DETERMINE LOCATION OF EQUIPMENT, JUNCTION BOXES, OUTLET BOXES, WIRE WAYS, PANELS, ETC. SEE ARCH FOR EXACT DIMENSIONS.
- B. ALL CONDUIT ROUTED UNDER A DRIVEABLE SURFACE SHALL BE SCHEDULE 80 PVC.

CONDUCTORS & CONDUIT TO BE REMOVED

CIRCUIT BREAKER, MOLDED CASE SWITCH

METER

PANEL

MAIN GROUNDING BAR

TRANSFORMER

CONNECTION TO GROUND

ST PARKING LIGHTING ST COUNTY HEALTH CENTER) NE 8TH, GRESHAM, OR 97030

County

401 N. Dixon Street Portland, OR 97227-1865

Mark	Date	Description of Revision


Multco Project Number:

ABBRIVIATIONS, SYMBOLS, LEGEND

02/26/2025 EL-100-1

	LUMINAIRE SCHEDULE										
TYPE MARK	LOCATION	DESCRIPTION	MANUFACTURER	MODEL	DIMMING	CCT/CRI	DELIVERED LUMENS WA	TTAGE	VOLTAGE	FINISH	NOTES
P01	SITE	POLE MOUNTED SINGLE HEAD LED FIXTURE WITH FULL CUT-OFF OPTICS. PROVIDE WITH 25' TALL SQUARE POLE TO MATCH EXISTING POLES AND COORDINATE MOUNTING ACCESSORY TYPE WITH EXISTING. CLEAR GASKETED TEMPERED GLASS LENS. TYPE IV DISTRIBUTION. IP66 RATED FOR WET LOCATIONS. PROVIDE WITH NLIGHT AIR WIRELESS CONTROLS FOR DIMMING, MOTION AND DAYLIGHT CONTROLS SUITABLE FOR 25FT HEIGHT POLE.	LITHONIA	RSX2 LED-P4 SERIES	0-10V DIMMING TO 10%	3000K	23054 lm 1	87 W	277 V	STANDARD TO MATCH EXISTING	PROVIDE UNIVERSAL 120-277VOLTS
P01A	SITE	SAME AS P01 EXCEPT MOUNTED TO EXISTING POLE. COORDINATE MOUNTING ACCESSORY NEEDED WITH EXISTING POLE TYPE.	LITHONIA	RSX2 LED-P4 SERIES	0-10V DIMMING TO 10%	3000K	23054 lm 1	87 W	277 V	STANDARD TO MATCH EXISTING	PROVIDE UNIVERSAL 120-277VOLTS
P01B	SITE	SIMILAR TO P01 EXCEPT TYPE II DISTRIBUTION.	LITHONIA	RSX2 LED-P4 SERIES	0-10V DIMMING TO 10%	3000K	22836 lm 1	87 W	277 V	STANDARD TO MATCH EXISTING	PROVIDE UNIVERSAL 120-277VOLTS
P01C	SITE	SIMILAR TO P01A EXCEPT TYPE II DISTRIBUTION.	LITHONIA	RSX2 LED-P4 SERIES	0-10V DIMMING TO 10%	3000K	22836 lm 1	87 W	277 V	STANDARD TO MATCH EXISTING	PROVIDE UNIVERSAL 120-277VOLTS

1 LIGHITNG SITE PLAN 1" = 30'-0"

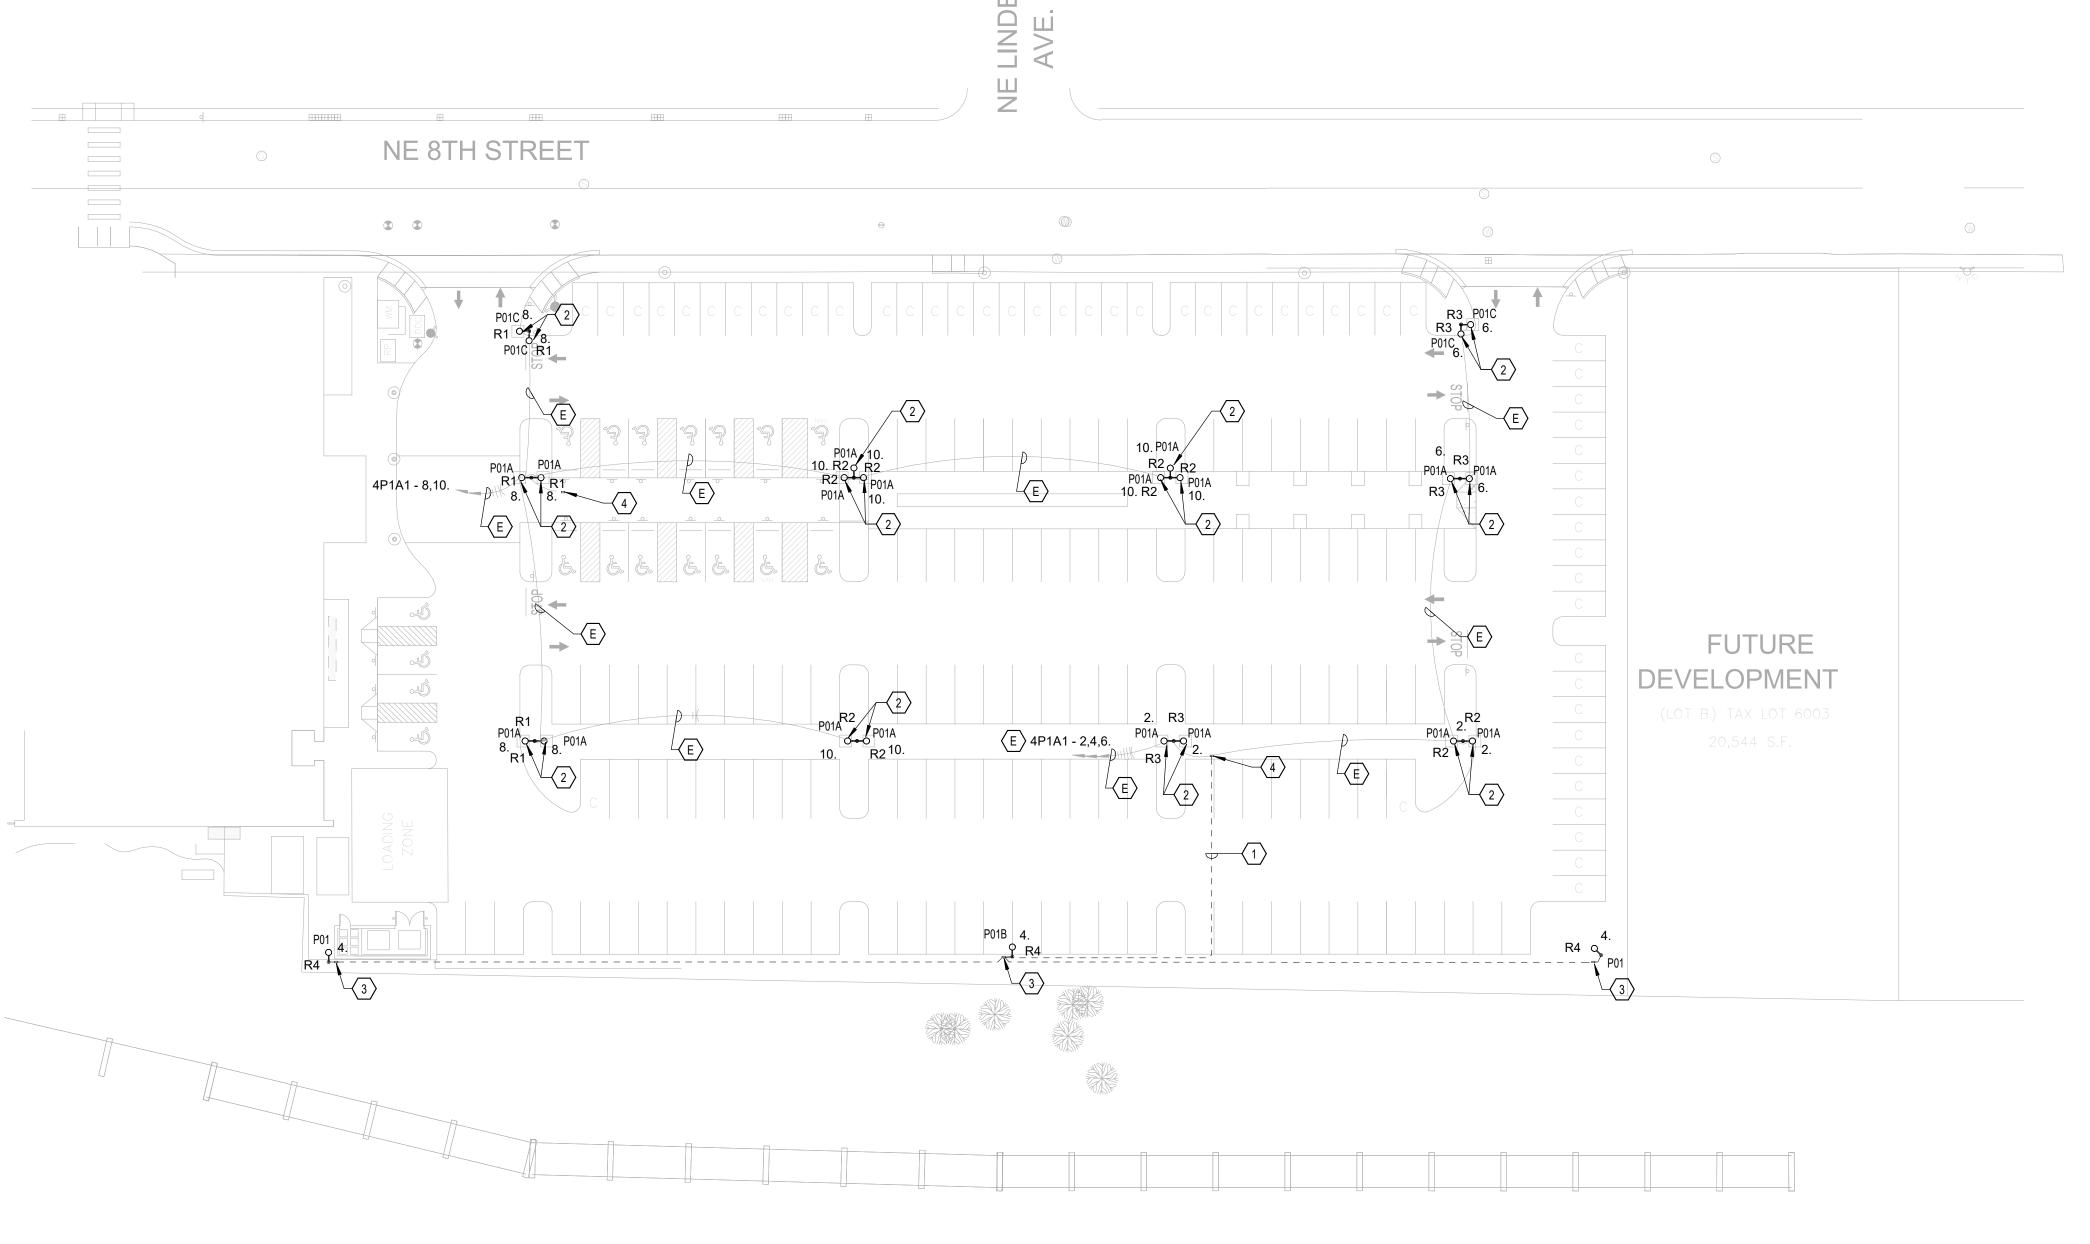

GENERAL NOTES:

- A. CONNECT NEW LIGHTS TO EXISTING CIRCUIT. EXTEND AS REQUIRED.
- B. PROVIDE CLASS 2 WIRING TO EXTERIOR LIGHTS AS REQUIRED FOR THE nLIGHT SYSTEM.
- C. REFER TO DETAIL 2 ON E-400-1 FOR POLE BASE DETAIL.



County

Facilities & Property Management 401 N. Dixon Street Portland, OR 97227-1865

KEY NOTES:

- SAW CUT OR BORE 1" SCHEDULE 40 PCV CONDUIT FROM EXISTING SITE LIGHTING POLE TO NEW HANDHOLE. PATCH AND REPAIR AS REQUIRED.
- MOUNT NEW LIGHTING HEAD TO EXISTING POLE. MAINTAIN POLE AND CIRCUITING FOR RECONNECTION TO NEW HEAD.
- 3. REFER TO DETAIL 1 ON SHEET EL-400-1 FOR HANDHOLE.
- 4. EXISTING HANDHOLE

AST PARKING LIGHTING AST COUNTY HEALTH CENTER 10 NE 8TH, GRESHAM, OR 97030

L	ı L	60 60	
Mark	Date	Description of Revision	Ву

Drawn By:

WBD

HG

Building Number:

Approved By:

FVR

Multco Project Number:

Sheet Title
SITE LIGHTING
PLAN

02/26/2025

EL-101-1






- 1. EXTEND CIRCUITS SERVING EXTERIOR SITE LIGHTING TO NEW nLIGHT CONTROLLER IN ELECTRICAL ROOM 301.

 CONNECT EXTERIOR CIRCUITS TO RELAY "R1" AS SHOWN ON SITE PLAN.
- 2. REMOVE EXTERIOR SITE LTG EAST CIRCUITS FROM LCP AND REROUTE TO NEW nLIGHT CONTROLLER.
- 3. ROUTE MINIMUM 1" CONDUIT FROM nLIGHT CONTROLLER LOCATION TO UPS PANEL IN 3RD FLOOR TELECOM ROOM. ROUTE THROUGH ELECTRICAL ROOM AND OFFICES TO TELECOM ROOM THEN UP TO THIRD FLOOR.
- 4. PROVIDE A nLIGHT ECLYPSE SYSTEM CONTROLLER COMPATITABLE WITH nLIGHT ENVISION SOFTWARE.
- 5. PROVIDE NPOD TOUCH CONTROLL PANEL FOR ON/OFF PROGRAMMING.



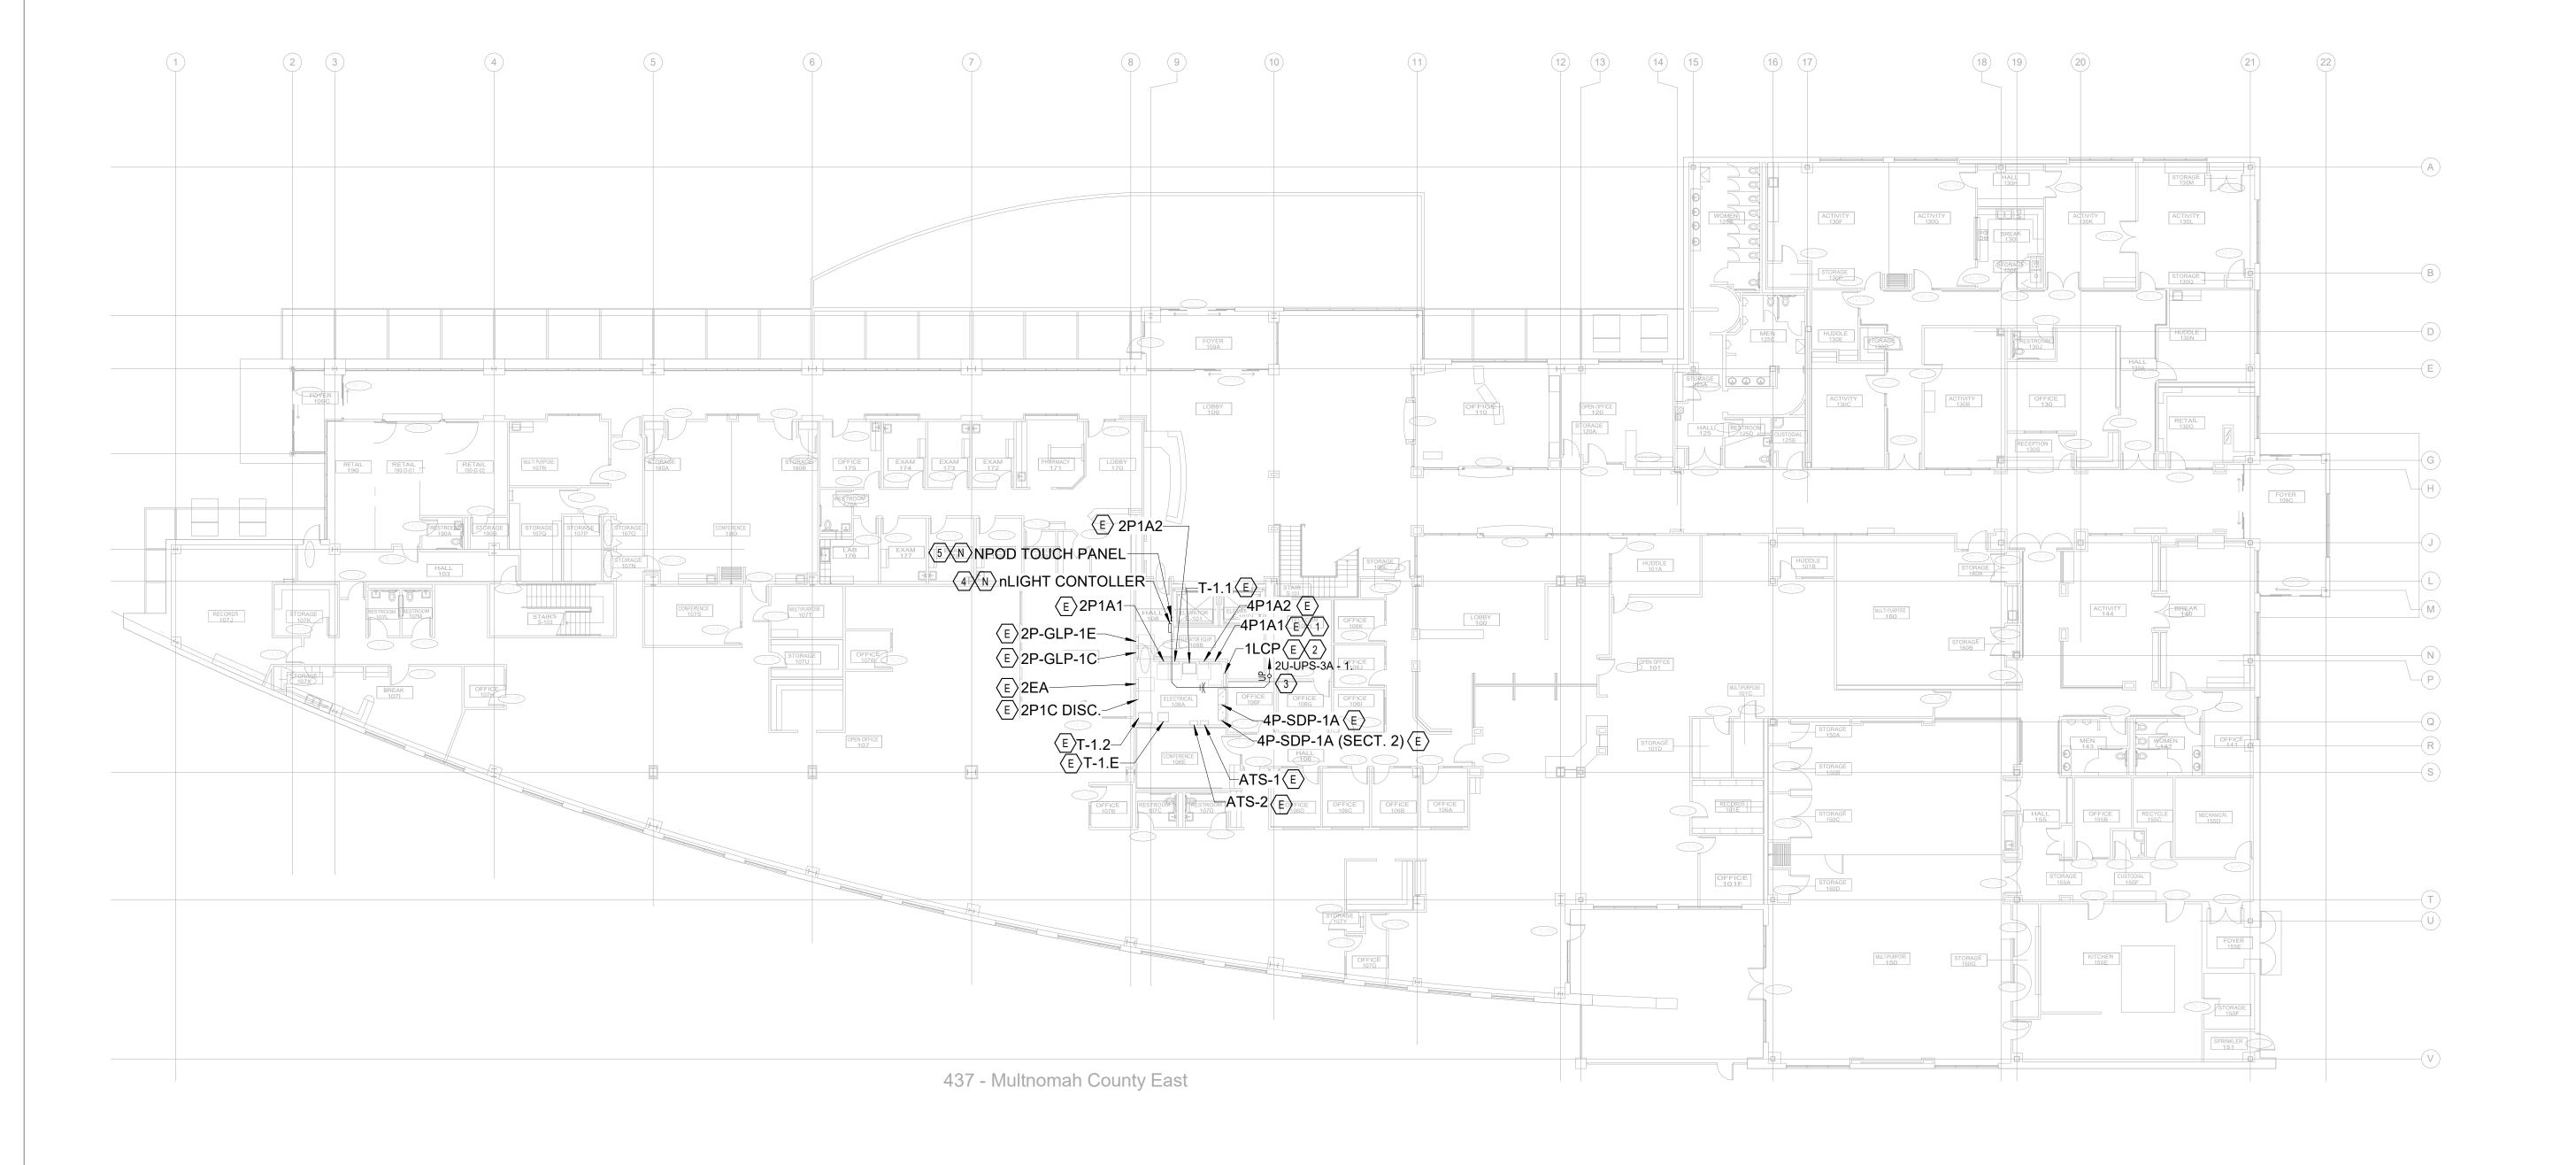

1 Level 1 1/16" = 1'-0"



Drawn By:

WBD

HG

Building Number:

Approved By:

FVR

Multco Project Number:

Sheet Title


LIGHTING FLOOR


PLAN


02/26/2025

EL-102-1 Sheet Of

02/26/2025 EL-102-3
Sheet Of

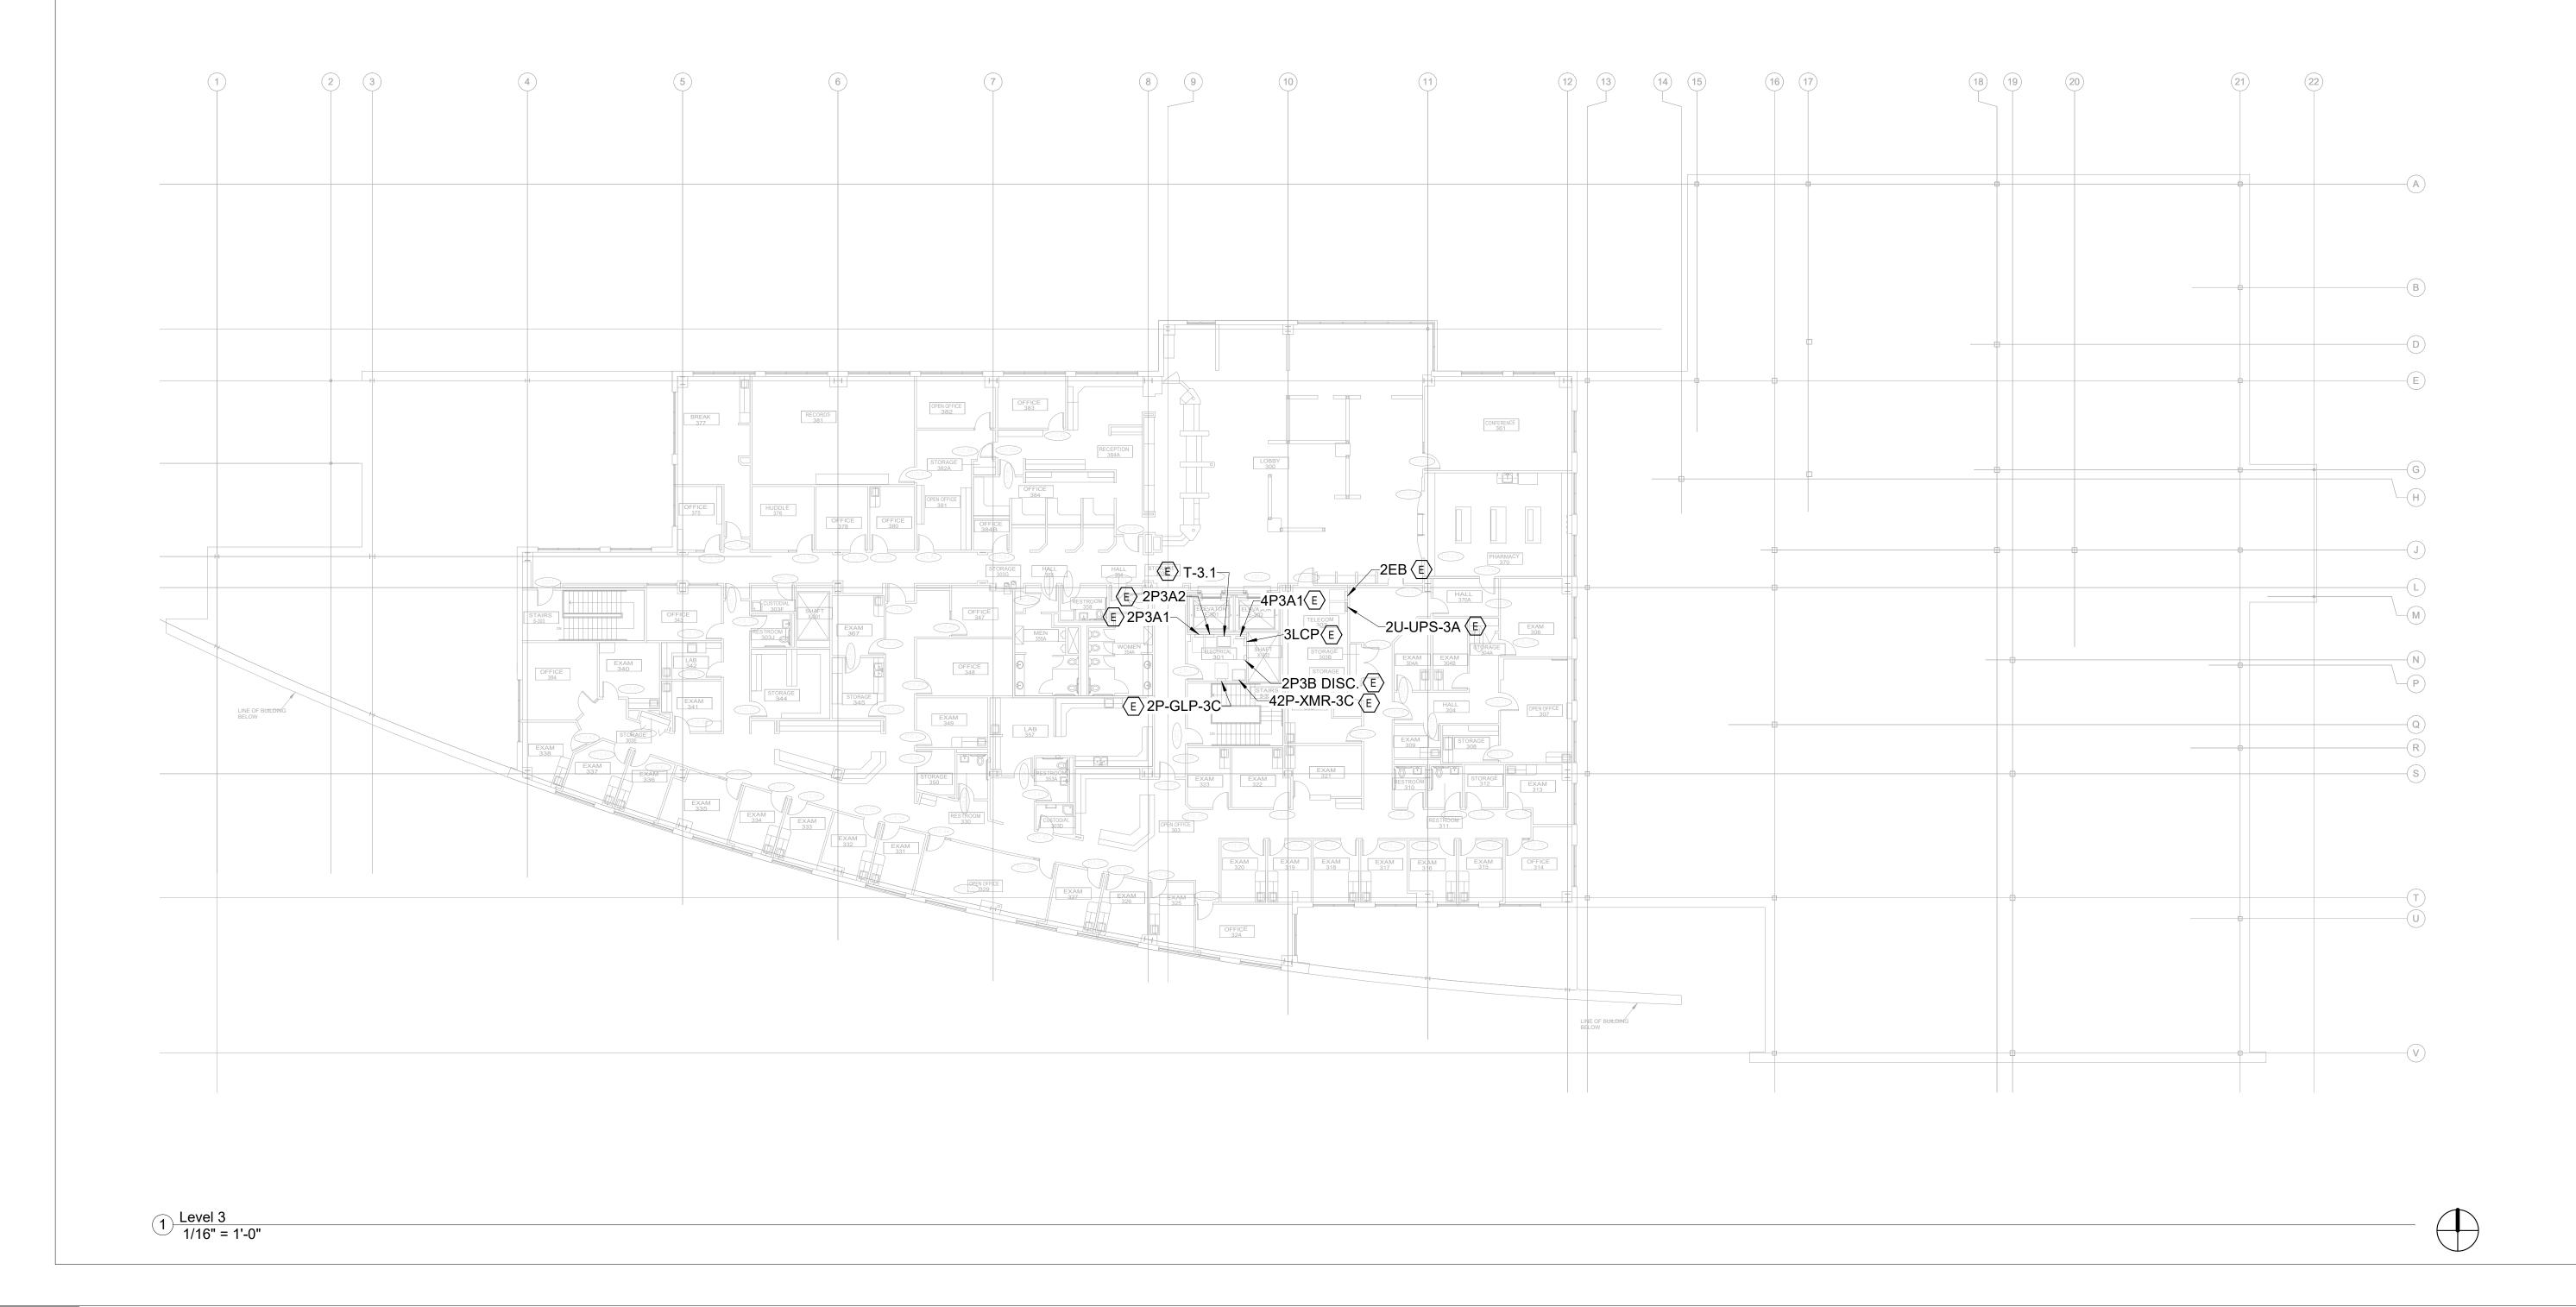

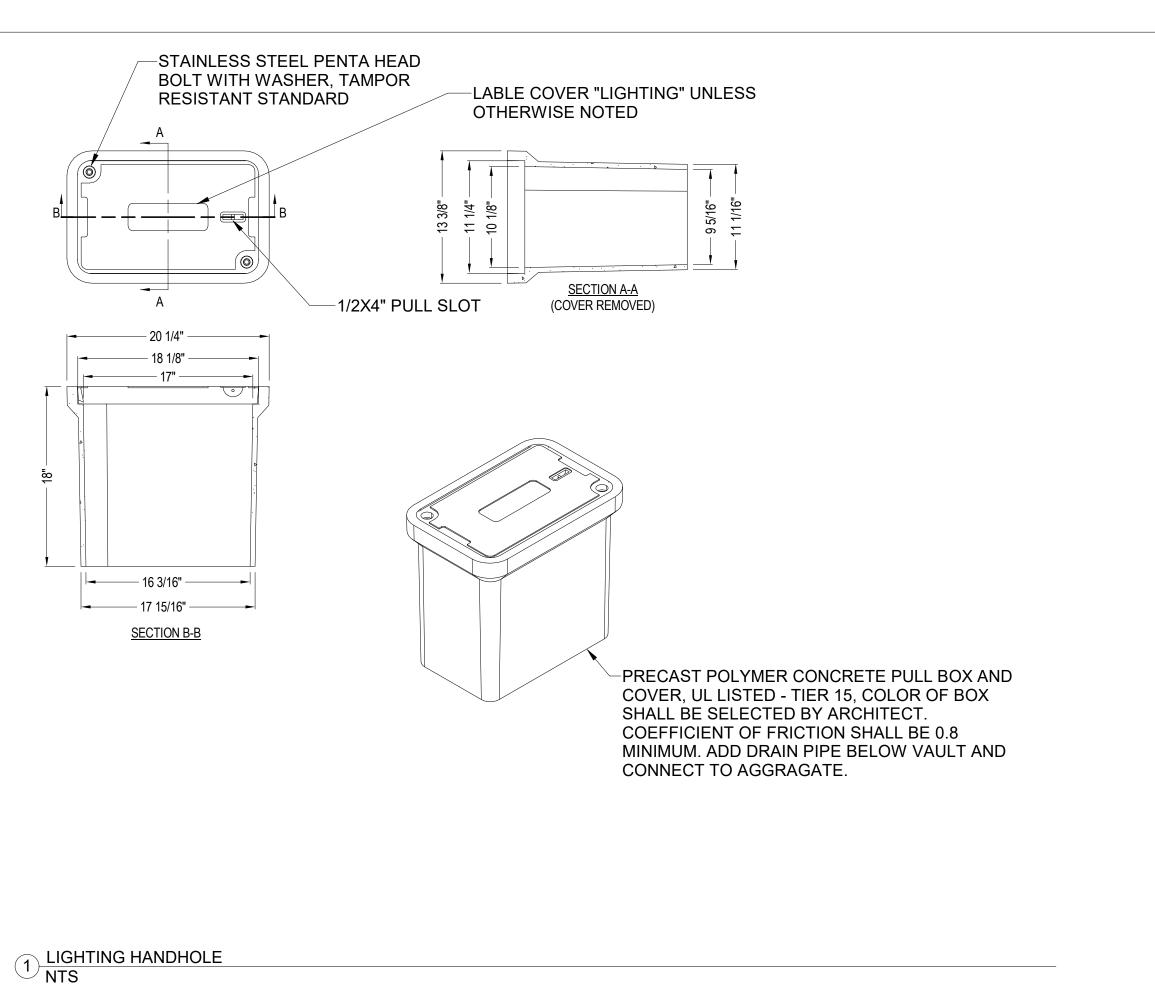

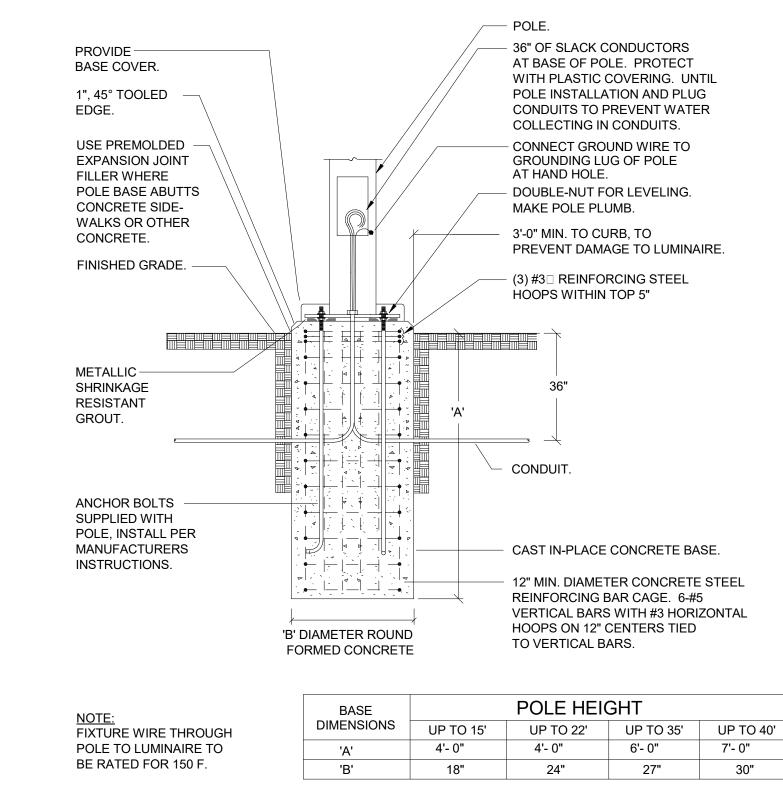

POLE BASE DETAIL NTS

EAST PARKING LIGHTING EAST COUNTY HEALTH CENTER 600 NE 8TH, GRESHAM, OR 97030

Multnomah

County

Facilities & Property Management

EXPIRES 12/31/2026

401 N. Dixon Street Portland, OR 97227-1865

Drawn By:

WBD

Checked By:

HG

Building Number:

Approved By:

FVR


Multco Project Number:

LIGHTNG DETAILS

02/26/2025

EL-400-1

Branch Panel: 4P1A Location: Supply From: 4P-SDP-1A Mounting: SURFACE Enclosure: NEMA 1		Volts: 480/277 Wye A.I.C. Rating: EXISTING Phases: 3 Available Fault Current: EXISTING Wires: 4 Mains Rating: 400 A MCB Rating: 400A											
CKT Circuit Description													
T Circuit Description SPARE ON	Trip 20 A	Poles	0	A 748		B		C	Poles	Trip	Circuit Description EXTERIOR SITE LTG	CKT 2	
SPARE OFF	20 A		U	740	0	561			1		EXTERIOR SITE LTG	4	
EXTERIOR DOWN LIGHT	20 A						0	748	1		EXTERIOR SITE LTG	6	
LTG AREA 1P OFFICE, HALL	20 A	. 1	0	1122					1	20 A	EXTERIOR SITE LTG	8	
LTG AREA 1P ACTIVITIES	20 A	. 1			0	1496			1	20 A	EXTERIOR SITE LTG	10	
LTG AREA 1P RESTRROMS	20 A						0	0	1		WALKWAY LTG	12	
SPARE OFF	20 A		0	0					1		LTG AREA 1M OFFICE	14	
LTG AREA 1R CAFE.	20 A				0	0			1		LTG AREA 1C OPEN AREA	16	
LTG EXTERIOR SCONCE	20 A		^				0	0	1		RELAY 43 EXTERIOR LIGHTS CONTACTOR	18	
SPARE OFF	20 A		0	0					1		LTG AREA 1T RESOURCES	20	
SPARE OFF LTG AREA 1R CAFE.	20 A 20 A				0	0	0	0	1		SPARE OFF LTG AREA 1K WAITING	22	
LTG AREA TA CAFE. LTG AREA 1A RESTROOM	20 A		0	0	1		U	U	1		LTG AREA 1H EXAM ROOMS	26	
LIGHTS AREA 10 LOUNGE	20 A		0		0	0			1		LTG AREA 1J CONSULTING	28	
LTG AREA 1S KITCHEN	20 A						0	0	1		LTG AREA 11 OFFICE, STOR	30	
LTG AREA 1B HALL	20 A		0	0					1		LTG AREA 1IOPEN AREA	32	
LTG AREA 1B HALL	20 A	. 1			0	0			1	20 A	LTG AREA 1C ELEVATOR LOBBY	34	
LTG AREA 1N COMMUNITY RM.	20 A	1					0	0	1	20 A	LTG AREA 1C HALL 100	36	
PANEL 2P1C (2P-PNL-1B)	125 A	٦ 3	0	0					1		LTG AREA 1G CONF ROOM	38	
					0	0			1		LTG AREA 1F	40	
		 I Load:		/0 VA		 57 VA	0	0 B VA	1	20 A	LTG AREA 1F	42	
ghting - Exterior		4675 VA				125.00% 5844 VA				Total Conn. Load: 4675 VA Total Est. Demand: 5844 VA Total Conn. Current: 6 A			
										Tot	al Est. Demand Current: 7 A		
										100	ai Est. Demand Current. 7 A		
	CHITS AL	L CIRC	UITS ARI	E EXISTIN	lG								
S: D IS ONLY NEW EQUIPMENT TO EXISITNG CIR													

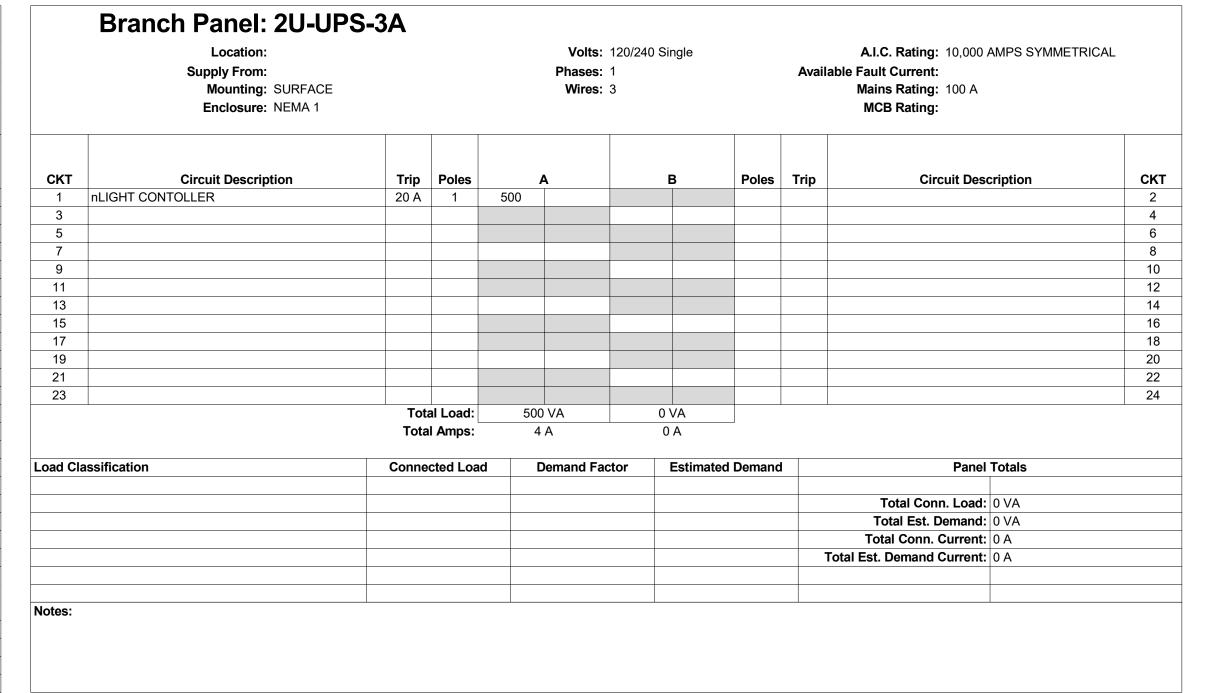

GENERAL NOTES:

- A. DEMOLITION WORK IS ACCOMMODATED WITH AN 'X' HEX, NUMBERED KEYNOTE, AND DASHED LINEWORK. EXISTING EQUIPMENT IS SHOWN AS HALFTONE. NEW WORK IS ACCOMODATED WITH AN 'N' HEX.
- B. UPON AWARD OF CONTRACT, PROVIDE 30-DAY ELECTRICAL PEAK LOAD DEMAND METERING ON PANELBOARD FEEDERS WHERE NEW CIRCUITS ARE BEING ADDED. REPORT PEAK AMPERES OR VOLT-AMPERES (VA) IMMEDIATELY TO THE ENGINEER AFTER TESTING COMPLETED.

KEYNOTES: (#)



Multnomah

County

Facilities & Property Management

401 N. Dixon Street Portland, OR 97227-1865



EAST PARKING LIGHTING EAST COUNTY HEALTH CENTER 600 NE 8TH, GRESHAM, OR 97030

WBD

Sheet Title


Multco Project Number:

Building Number: Approved By:

ONE-LINE DIAGRAM

02/26/2025

EL-600-1

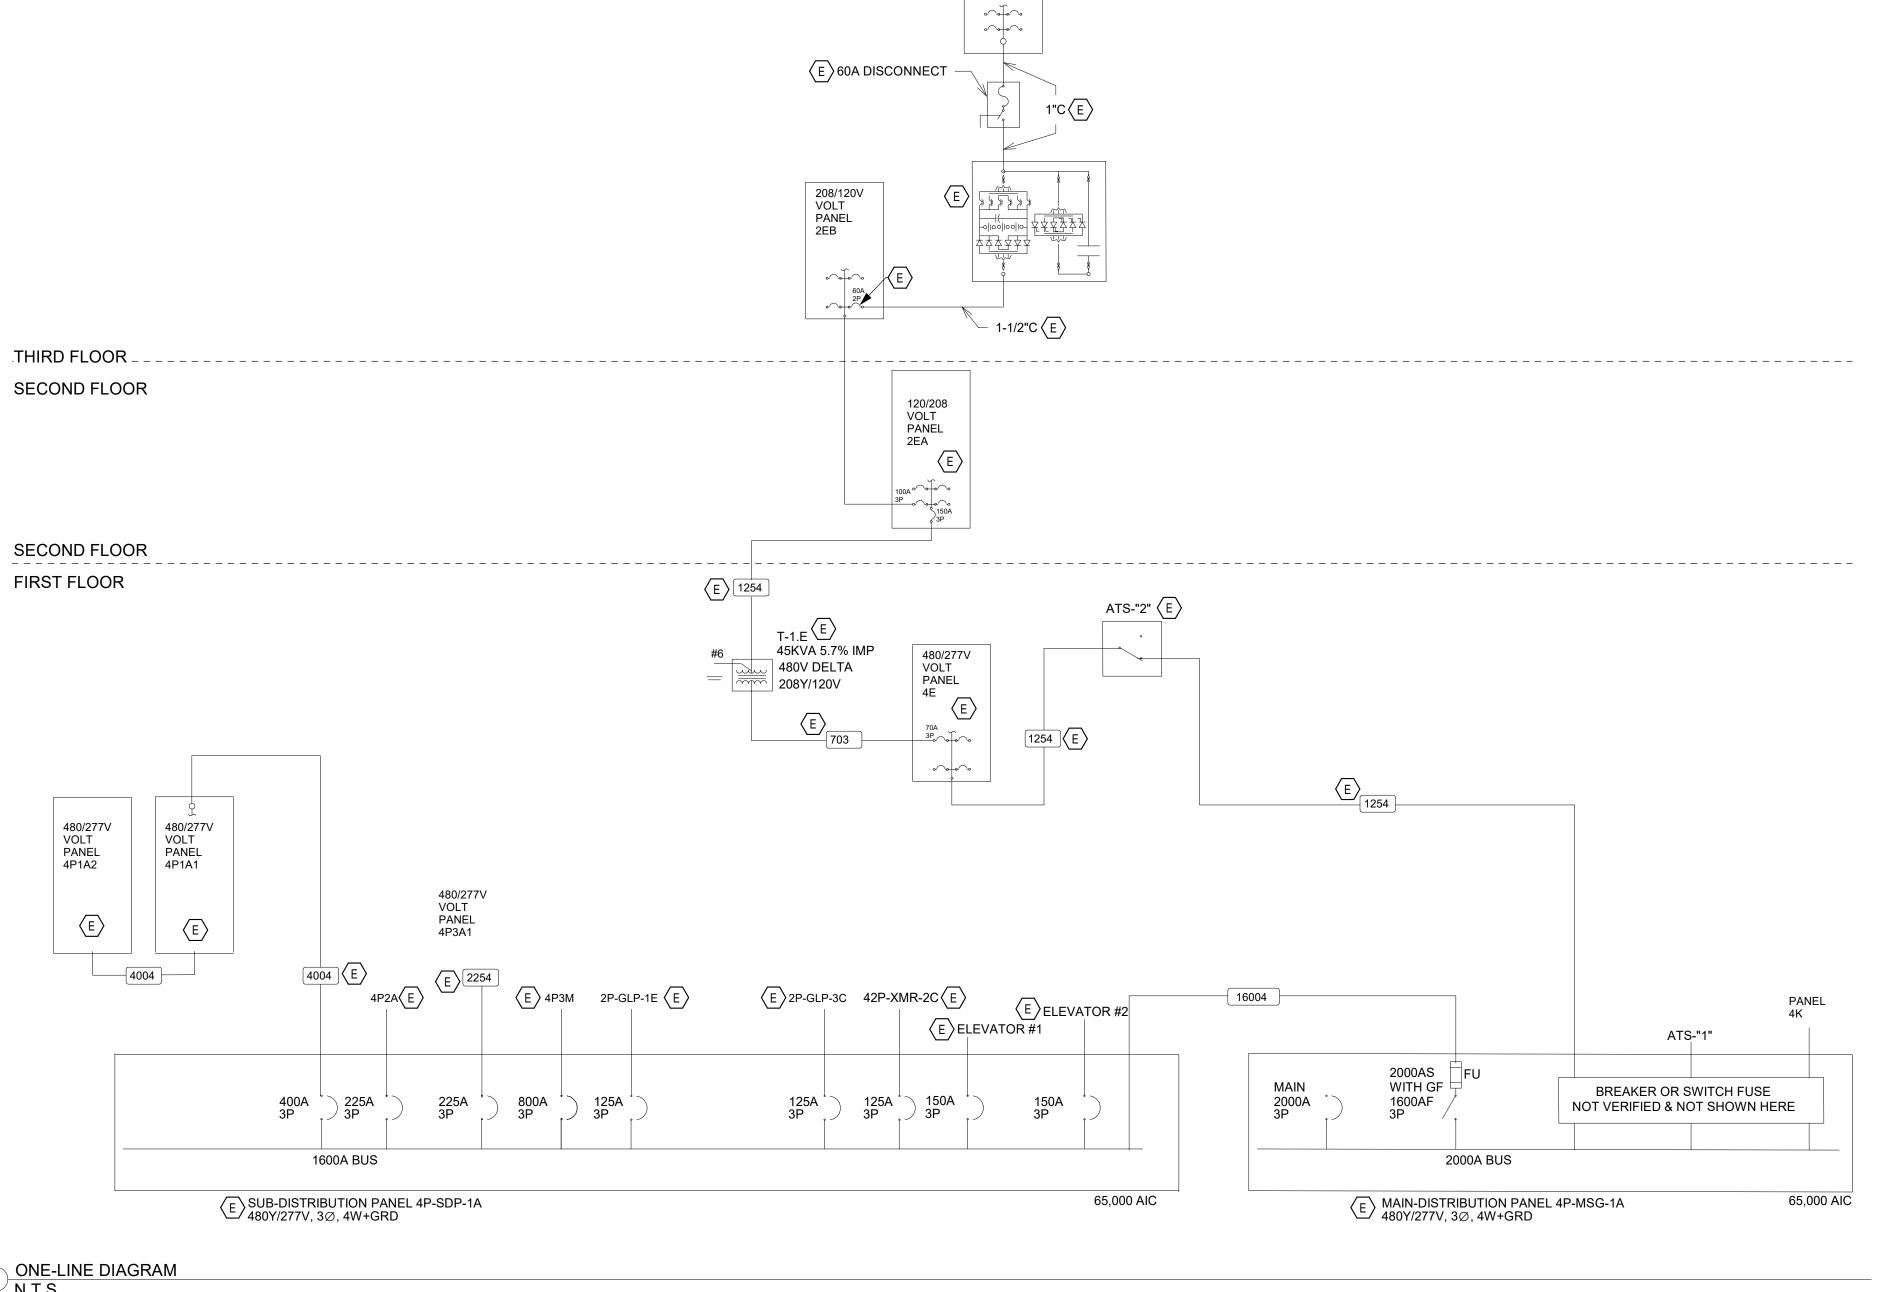

 $\langle E \rangle$

120/208 VOLT PANEL

2U-UPS-3A